

STAPLE



# basic education

Department:  
Basic Education  
REPUBLIC OF SOUTH AFRICA

**NATIONAL  
SENIOR CERTIFICATE**


**GRADE 12**

**ENGINEERING GRAPHICS AND DESIGN P1**  
**NOVEMBER 2021**

**MARKS: 100**

**TIME: 3 hours**

**This question paper consists of 6 pages.**

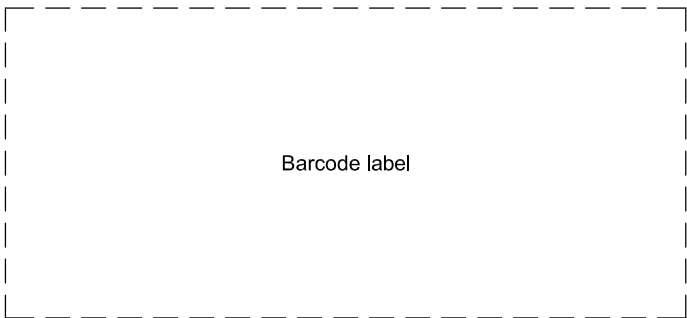

Barcode label



## INSTRUCTIONS AND INFORMATION

1. This question paper consists of FOUR questions.
2. Answer ALL the questions.
3. ALL drawings are in first-angle orthographic projection, unless otherwise stated.
4. ALL drawings must be prepared using pencil and instruments, unless otherwise stated.
5. ALL answers must be drawn accurately and neatly.
6. ALL the questions must be answered on the QUESTION PAPER, as instructed.
7. ALL the pages, irrespective of whether the question was attempted or not, must be re-stapled in numerical sequence in the TOP LEFT-HAND CORNER ONLY.
8. Time management is essential in order to complete all the questions.
9. Print your examination number in the block provided on every page.
10. Any details or dimensions not given must be assumed in good proportion.

FOR OFFICIAL USE ONLY															
QUESTION	MARKS OBTAINED			$\frac{1}{2}$	SIGN	MODERATED			$\frac{1}{2}$	SIGN	RE-MARKING			$\frac{1}{2}$	SIGN
1															
2															
3															
4															
TOTAL															
	2	0	0			2	0	0			2	0	0		

FINAL CONVERTED MARK	CHECKED BY
100	

<b>COMPLETE THE FOLLOWING:</b>
CENTRE NUMBER
CENTRE NUMBER
EXAMINATION NUMBER
EXAMINATION NUMBER



LAND SURVEYOR'S CERTIFICATE OF THE CORNER HEIGHTS AND BOUNDARY LENGTHS OF SUB-A AND SUB-B OF STAND 32.

CORNER HEIGHTS IN METRES		BOUNDARY LENGTHS IN METRES	
A	351,5	AB	38,16
B	349,2	BC	60
C	351,5	CD	38,16
D	352,2	DA	60
E	351,5	FD	33,8
F	351,7	EG	33,8
G	350,4	FG	34,56

**SYMBOL LEGEND:**

- SHRUBBERY
- PALM TREES
- DECIDUOUS TREES


**NOTE:**  
Contractors must verify all dimensions and levels on site before commencing work. Architects to be notified immediately of any discrepancies.

ARCHITECT'S SIGNATURE .....

CLIENT'S SIGNATURE .....

**ANSWER 20**

In the space below, draw, in neat freehand, the front view and top view of the SANS 10143 graphical symbol for a BIDET.

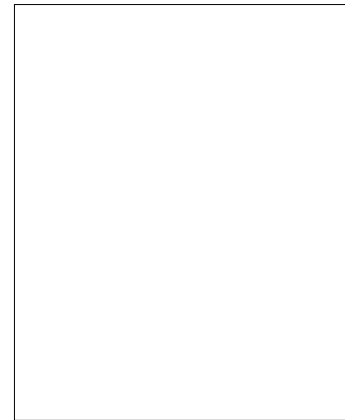

**QUESTION 1: ANALYTICAL (CIVIL)**

**Given:**

The site plan of newly subdivided STAND 32 with new boundary and building lines as well as a proposed new house and garage, a title panel and a table of questions. The drawing is not presented to the indicated scale.

**Instructions:**

Complete the table below by neatly answering the questions, which refer to the accompanying drawing, title panel and civil content. **[30]**

QUESTIONS		ANSWERS	
1	What is the project number?	1	
2	Who prepared the drawing?	1	
3	What is the date of the first revision?	1	
4	Name the company that printed the drawing.	1	
5	What size pipe is used for the new sewer line?	1	
6	What does the abbreviation IC at 1 stand for?	1	
7	What type of tree is indicated at 2?	1	
8	Name the constructed feature at 3.	1	
9	What is indicated by the arrow at 4?	1	
10	Name the feature at 5.	1	
11	How many inspection eyes are there on the proposed new house?	1	
12	In what colour should drain and soil pipes be indicated on drainage installation drawings?	1	
13	With reference to the building regulations, why should the existing outbuilding be demolished now?	2	
14	What is the fall of the existing sewer line?	1	
15	What is the shortest distance from the existing house to Austen Street in metres?	2	
16	With reference to the second revision, closest to which corner of SUB-B of STAND 32 should a new stormwater drain be placed?	1	
17	With reference to the north point, what is the direction of flow of the municipal sewer line?	2	
18	In the space below (ANSWER 18), determine the perimeter of SUB-B of STAND 32, including the new driveway, in metres.	3	
19	In the space below (ANSWER 19), determine the total area of the proposed new house in square metres.	3	
20	In the space in the title panel (ANSWER 20), draw, in neat freehand, the front view and top view of the SANS 10143 graphical symbol for a BIDET.	4	
<b>TOTAL</b>		<b>30</b>	

REVISION	DATE	DESCRIPTION
2	2021-02-14	ADD NEW STORM WATER DRAIN AT LOWEST CORNER
1	2021-01-23	INCREASE WIDTH OF DRIVEWAY

**CLASSIC DESIGN ARCHITECTS**  
459 CONCORD RD  
CAPE TOWN  
www.clasdes.co.za

PRINTED BY: DUPLEX PRINTING  
DATE OF PRINT: 2021-02-21

DRAWING TITLE:  
**SITE PLAN**


PROJECT:  
PROPOSED NEW HOUSE AND GARAGE ON SUBDIVISION B OF STAND 32 FOR ROSS WATSON, 25 AUSTEN STREET, PIKETBERG, 1965

PROJECT NUMBER: JBV-500W  
DRAWING NUMBER: AAG-2121

DATE: 2021-01-10  
DRAWN: JOHN  
CHECKED: WAYNE  
SCALE: 1 : 350


REFERENCE CODE: Q1R-2021

ANSWER 18. Show ALL calculations.

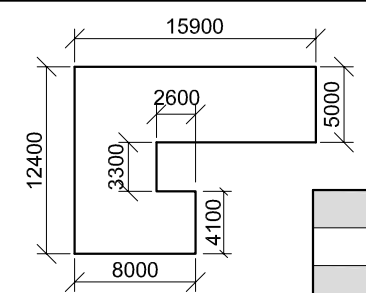

ANSWER 19. Show ALL calculations.

EXAMINATION NUMBER	
EXAMINATION NUMBER	2

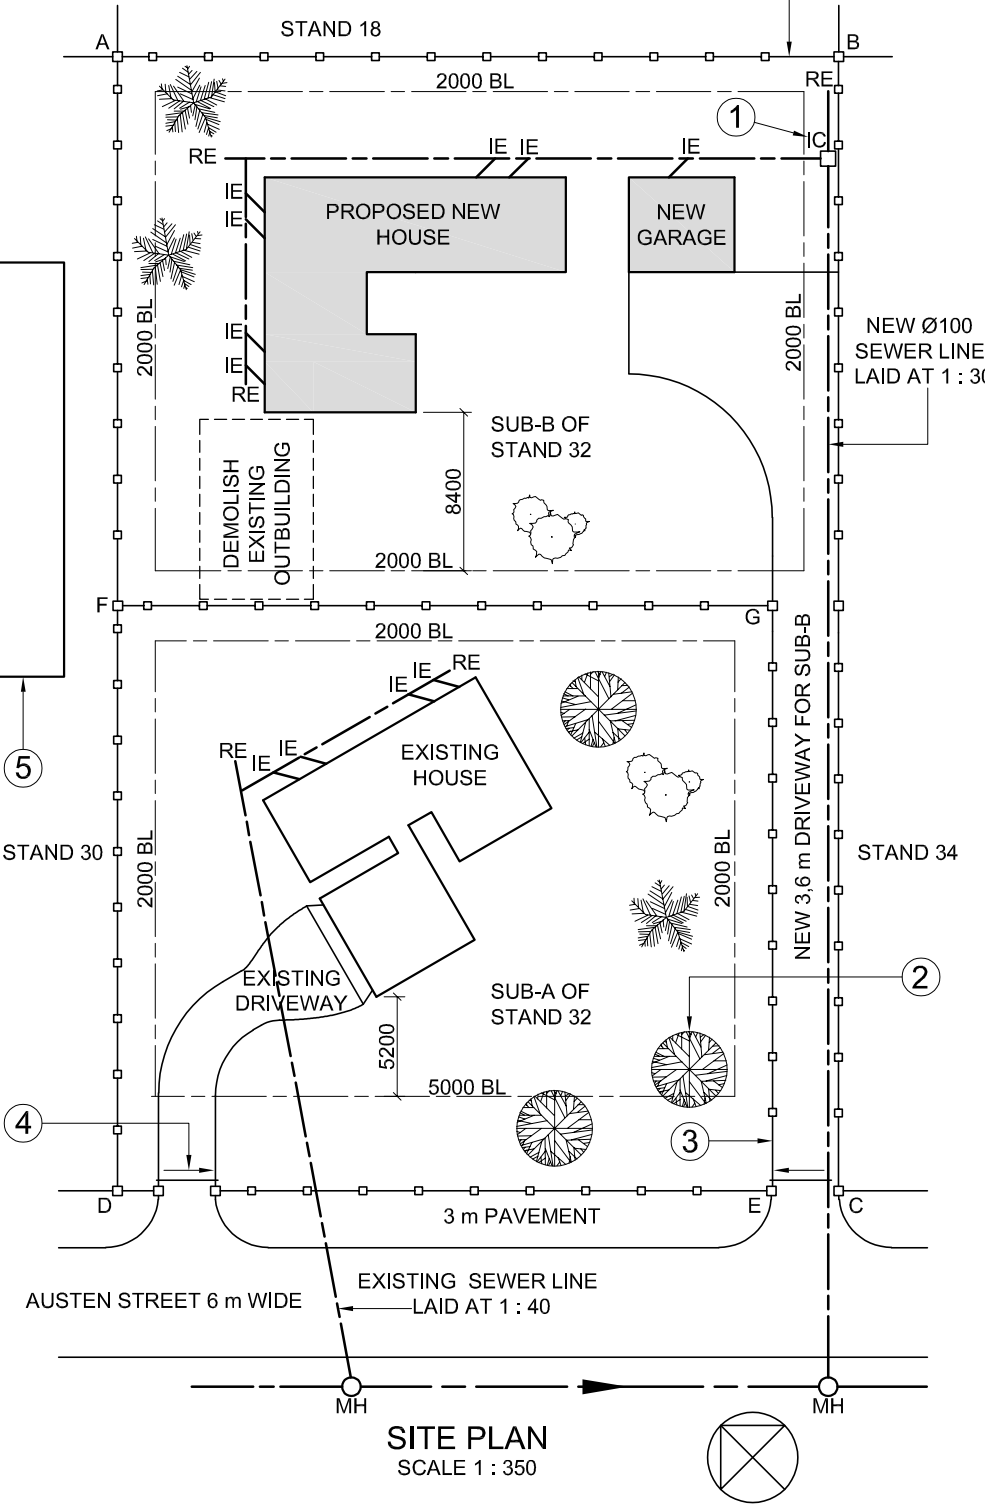



**QUESTION 2: INTERPENETRATION AND DEVELOPMENT**

**Given:**


- The top view and incomplete front view of a connecting piece for a ventilation system. The connecting piece consist of a right equilateral triangular tube and a right regular hexagonal tube. The axes of both tubes lie in a common vertical plane.
- An auxilliary view of the triangular tube.

**Instructions:**

Draw, to scale 1 : 1, the following views of the two tubes:


- 2.1 The given top view
- 2.2 The right view
- 2.3 The complete front view, clearly showing the curve of interpenetration
- 2.4 The development of the triangular tube. Make edge 'S-S' the seam.

- Planning is essential.
- Show ALL hidden detail and folding lines.
- Show ALL construction. **[38]**

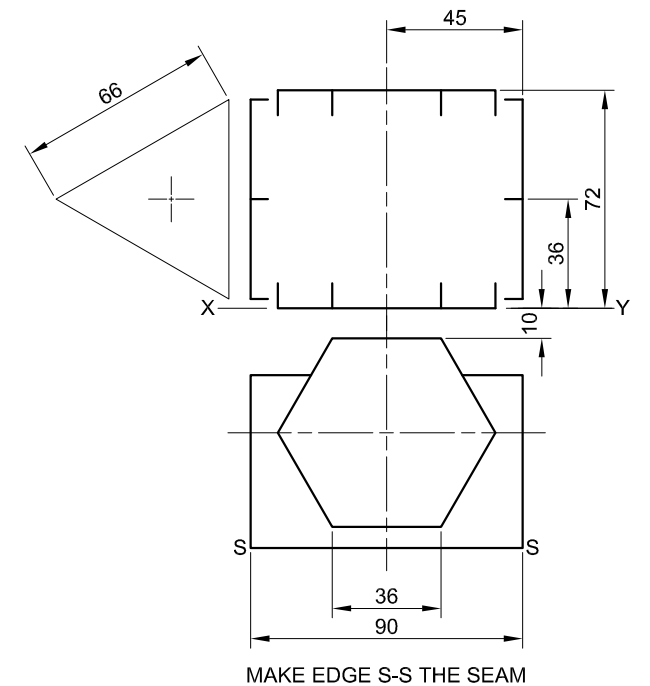

ASSESSMENT CRITERIA			
1	TOP VIEW	6	
2	RIGHT VIEW	5	
3	FRONT VIEW	16 1/2	
4	DEVELOPMENT	10 1/2	
PENALTIES (-)			
<b>TOTAL</b>		<b>38</b>	
EXAMINATION NUMBER			
EXAMINATION NUMBER			
EXAMINATION NUMBER			<b>3</b>



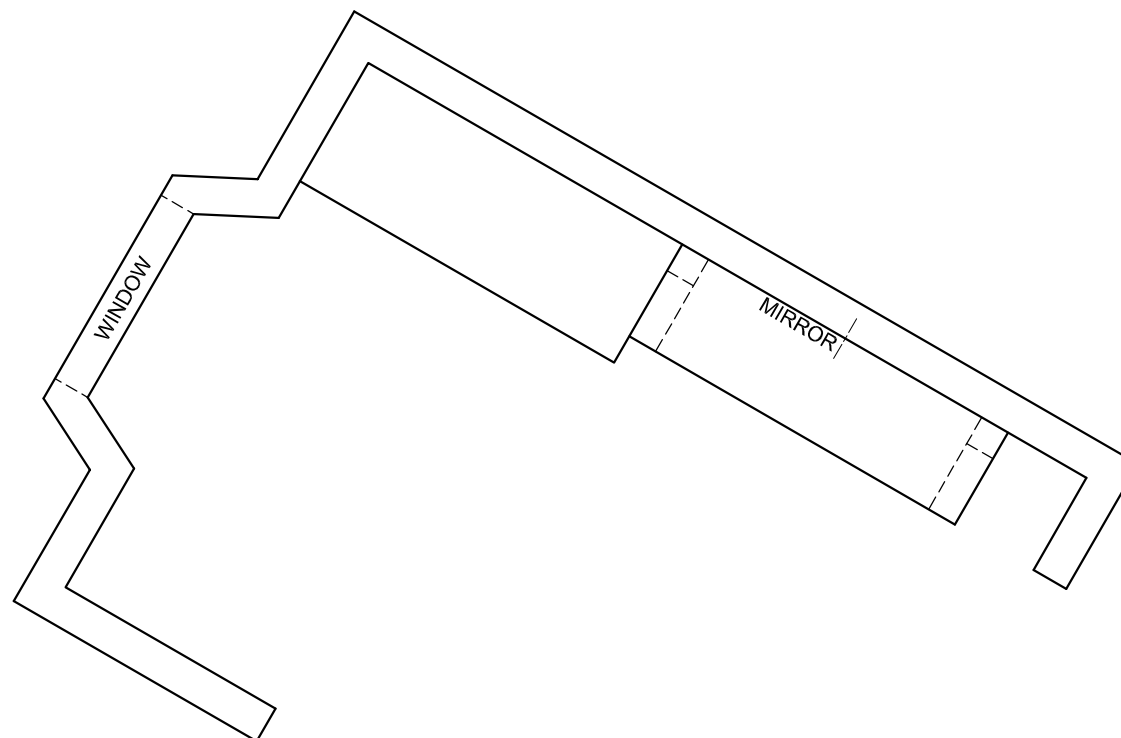

**QUESTION 3: PERSPECTIVE**

**Given:**

Three views of the inside of a dressing room and the information needed to draw a two-point perspective drawing

PP – Picture plane

HL – Horizon line

GL – Ground line



SP – Station point

**Instructions:**

Complete the perspective drawing.

- Align the drawing sheet with the ground line (GL).
- Determine and label the vanishing points.
- Show ALL construction.
- NO hidden detail is required. **[40]**

PP

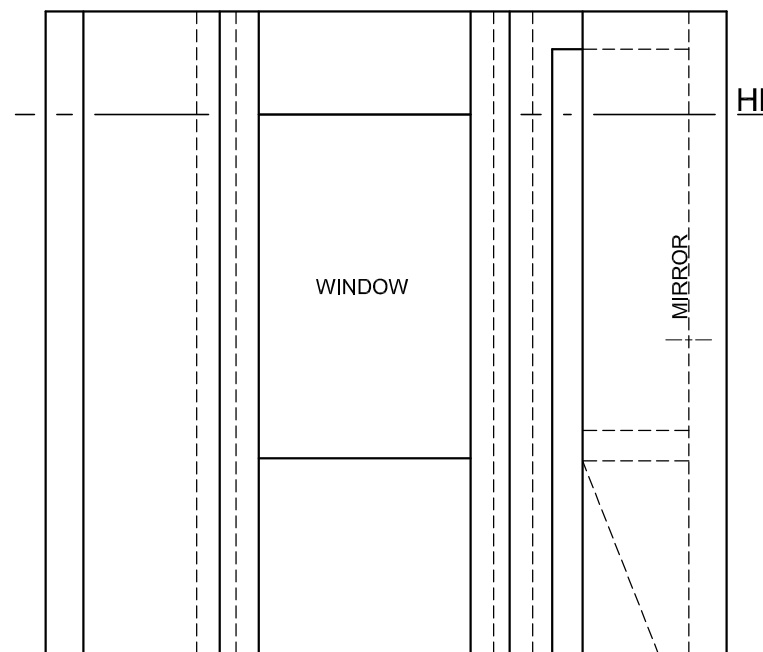
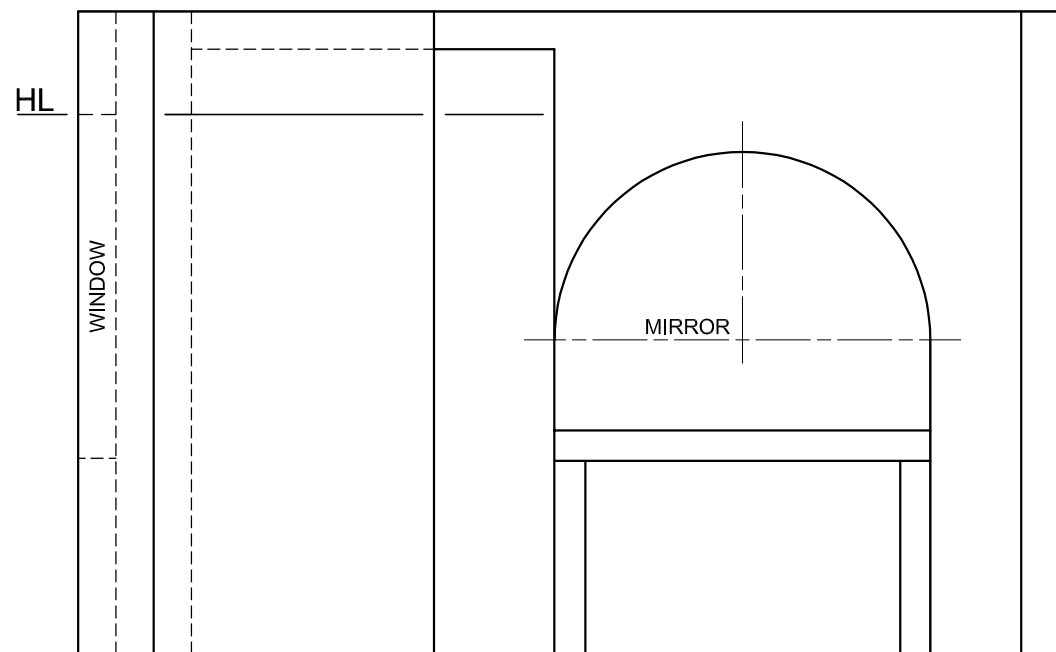


+


SP

ASSESSMENT CRITERIA			
1	CONSTRUCTION	6	
2	WALLS + CUPBOARD + WINDOW	20	
3	TABLE + MIRROR	14	
PENALTIES (-)			
<b>TOTAL</b>		<b>40</b>	
EXAMINATION NUMBER			
EXAMINATION NUMBER			
			<b>4</b>



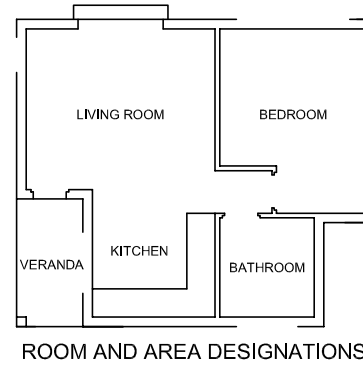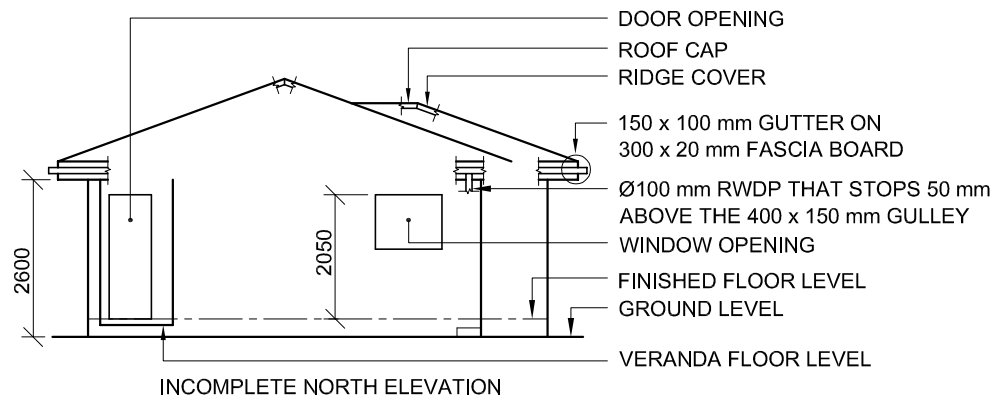

**FLOOR FINISHES**  
 BEDROOM: CARPET  
 BATHROOM: TILES  
 LIVING ROOM: WOOD  
 KITCHEN: TILES  
 VERANDA: TILES

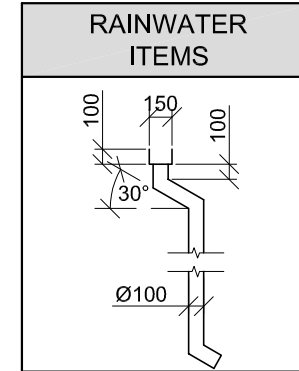

**QUESTION 4: CIVIL DRAWING**

**Given:**

- The incomplete north elevation of a **new house**, showing the walls, the window and door openings, the veranda, the roof and labels
- The incomplete floor plan showing the walls, positions of the doors, windows, fixtures and electrical layout
- A schematic diagram of a roof truss at A-A and roof notes
- The incomplete foundation, external wall and veranda detail
- Room and area designations as well as floor finishes
- A table of rainwater items
- A door and window schedule
- A table of electrical symbols
- A table of roof components
- A table of fixtures
- The incomplete floor plan and the ground line of the **new house**, drawn to scale 1 : 50, and the incomplete foundation and a break line for the detailed section, drawn to scale 1 : 20, on page 6.

**Instructions:**

Answer this question on page 6.

- 4.1 Using the given incomplete floor plan, draw, to scale 1 : 50, the following views of the **new house**:

**4.1.1 THE COMPLETE FLOOR PLAN**

**Add the following features to the drawing:**

- ALL doors and windows
- ALL fixtures as indicated by the abbreviations
- ALL electrical fittings as indicated by the numbers
- The complete roof lines
- ALL hatching detail

**4.1.2 THE COMPLETE NORTH ELEVATION**

**Show the following features on the drawing:**

- The outside walls, veranda, window and door detail
- The roof detail, including the fascia boards, gutters, rainwater down-pipe and gulley
- The finished floor level

- 4.2 Using the given foundation and break line on page 6, draw, to scale 1 : 20, a **DETAILED SECTION** on cutting plane A-A of the area in the ellipse shown on the incomplete floor plan.

**Show the following features on the drawing:**


- The complete foundation, external wall and window detail
- The roof detail, including the fascia board, gutter, rainwater down-pipe and gulley
- The wash basin to the west of cutting plane A-A
- ALL hatching detail. ONLY the substructure hatching may be drawn in neat freehand.

**Label the following:**

- The north elevation
- The floor finishes
- Ground level, finished floor level and damp-proof course (use the correct abbreviations and show it on ALL the relevant views)

**NOTE:**

ALL drawings must comply with the **guidelines** and **graphical symbols** as contained in the **SANS 10143**. [92]

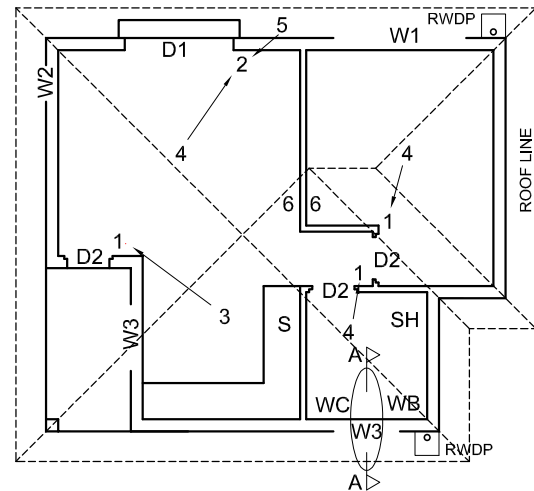

**FEATURES**

- D1** SLIDING DOOR
- D2** DOOR
- W1** WINDOW
- W2** WINDOW
- W3** WINDOW

**FIXTURES**


- WC** TOILET
- WB** WASH BASIN
- SH** SHOWER
- S** SINK

**ELECTRICAL FITTINGS**

- ONE-WAY SWITCH - SINGLE-POLE
- ONE-WAY SWITCH - DOUBLE-POLE
- FLUORESCENT LIGHT 3 x 45 W
- CEILING LIGHT
- WALL-MOUNTED LIGHT
- SWITCHED SOCKET OUTLET



**NOTE:**

THE ARROW SHOWS THE LIGHT CONNECTION TO THE SWITCH.

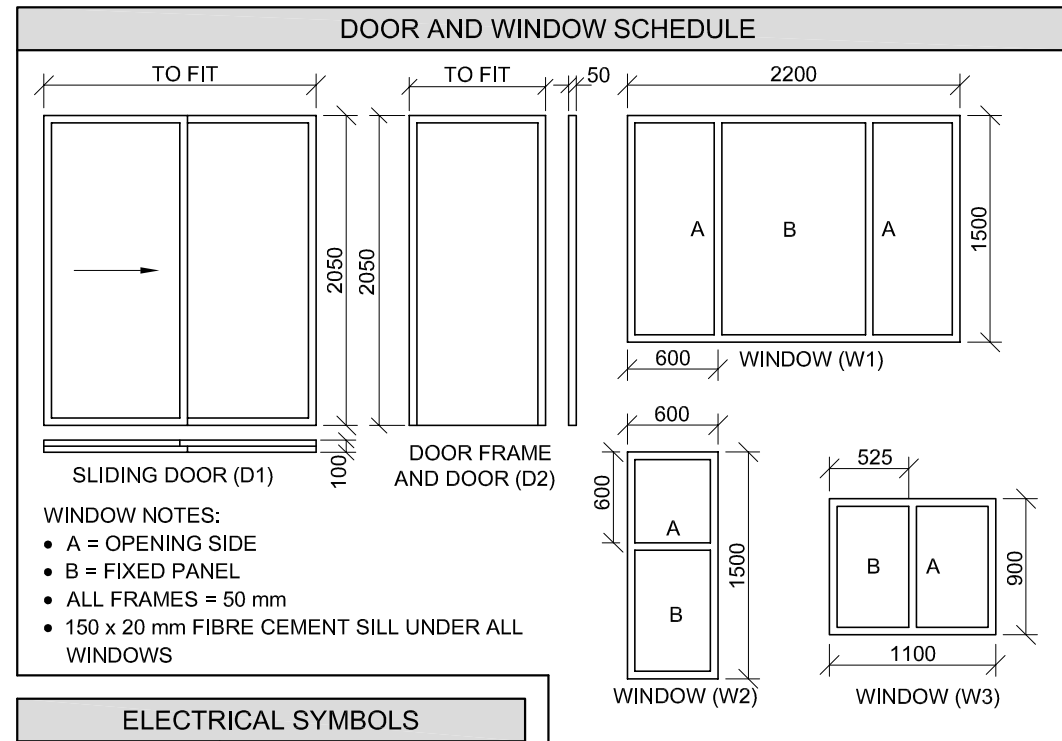

ELECTRICAL SYMBOLS	

ROOF COMPONENTS	
	300 x 20 mm FASCIA BOARD
	150 x 100 mm GUTTER
	ROOF CAP AND RIDGE COVER

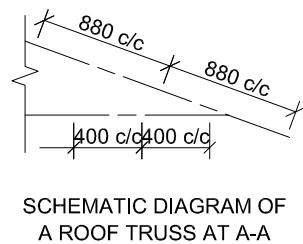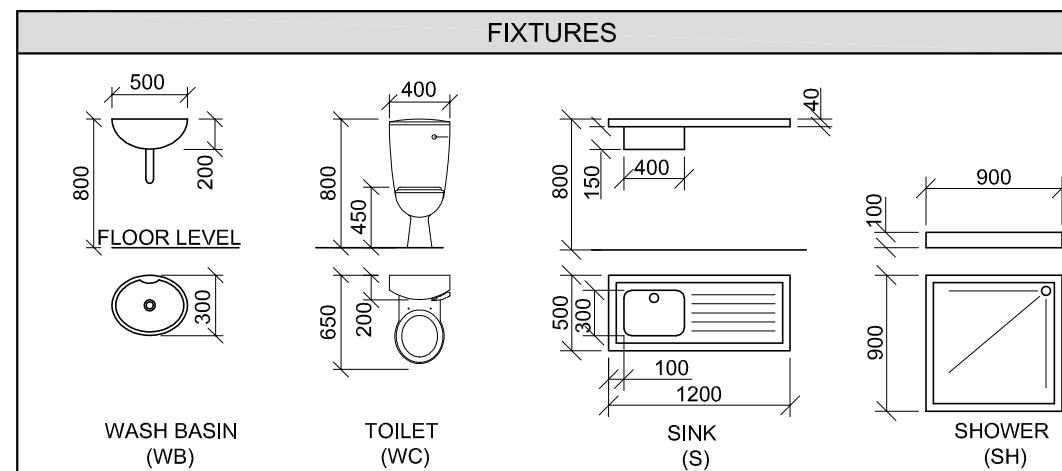

**ROOF NOTES:**

20° ROOF PITCH


114 x 40 mm ROOF TRUSSES ON  
 114 x 40 mm WALL PLATES

500 mm ROOF OVERHANG TO END OF  
 ROOF TRUSS

20 mm FIBRE CEMENT ROOF SHEET  
 ON 75 x 50 mm PURLINS @ 880 mm c/c


300 x 20 mm FASCIA BOARD WITH  
 150 x 100 mm GUTTER ON ALL SIDES

10 mm CEILING BOARD ON 40 x 40 mm  
 BRANDING STRIPS @ 400 mm c/c

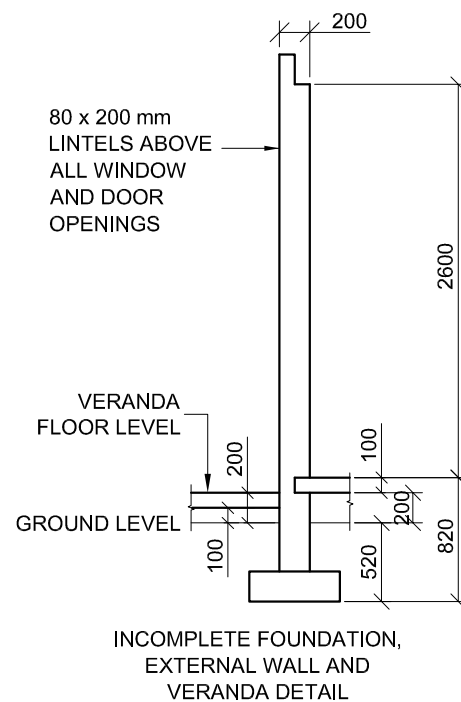



GL

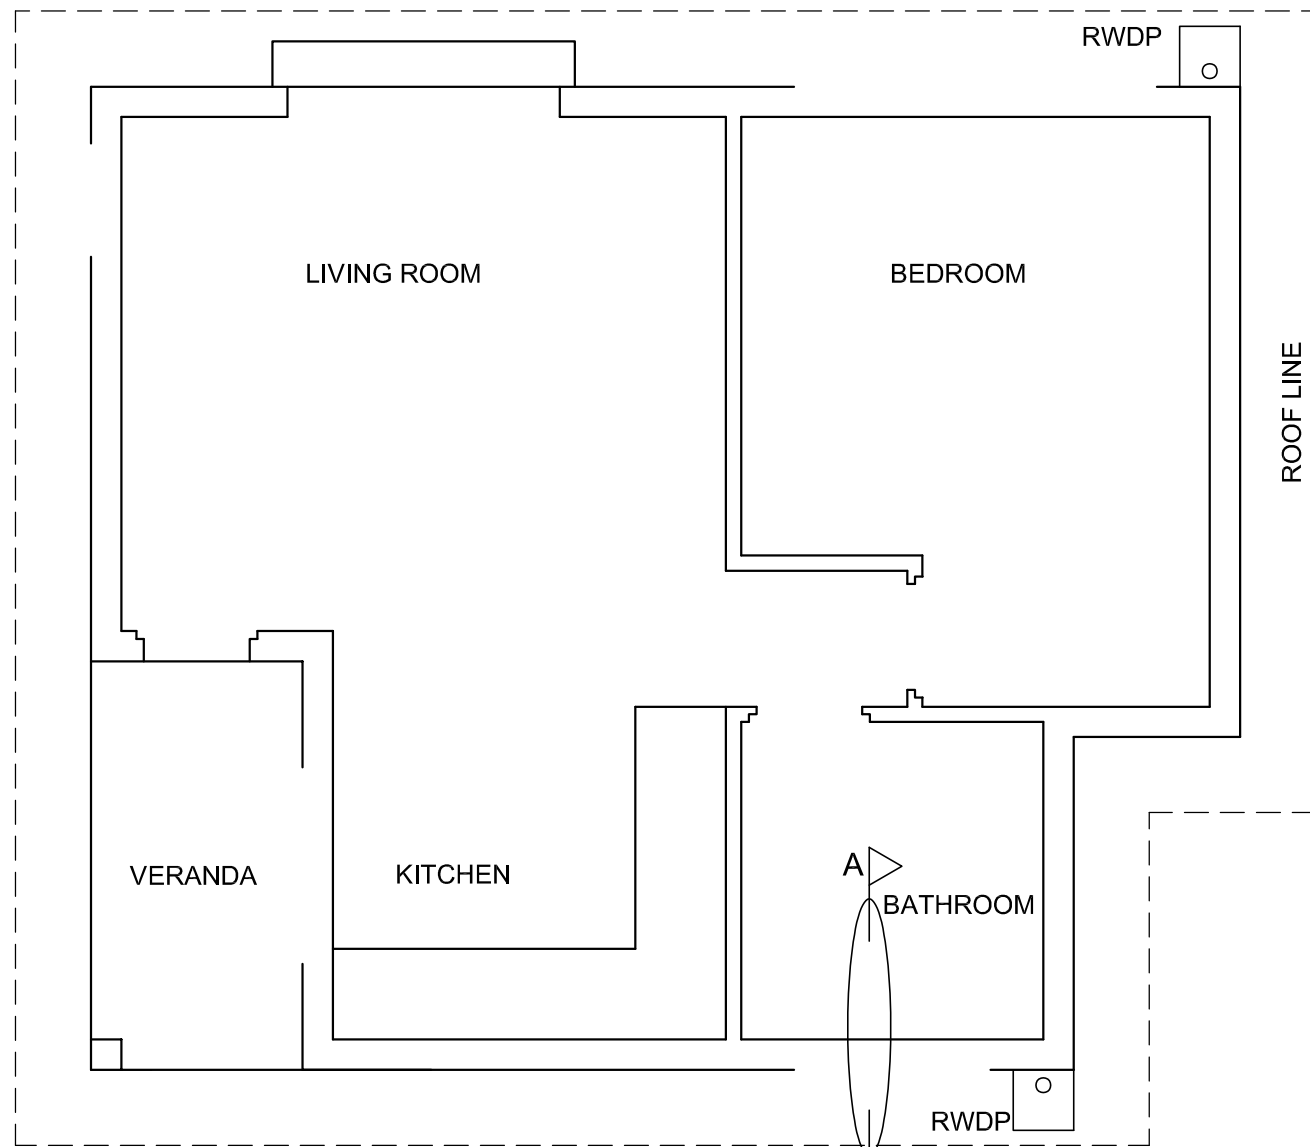

FLOOR PLAN  
SCALE 1 : 50



WESTERN CAPE



SECTION A-A  
SCALE 1 : 20

MARK ALLOCATION FOR SECTION OF ROOF		FOR OFFICIAL USE ONLY	
A		INCORRECT SCALE(S) USED	
B		NON-ALIGNMENT OF VIEWS	
C		VIEW(S) ROTATED	
D		SECTION VIEWED INCORRECTLY	
E		INCORRECT LETTERING	
F			
G			
H			
<b>TOTAL</b>		<b>TOTAL</b>	

ASSESSMENT CRITERIA				
FLOOR PLAN				
		POSSIBLE	OBTAINED	SIGN MODERATED
1	DOORS + WINDOWS	13		
2	FIXTURES + ROOF LINES	11		
3	ELECTRICAL	8 1/2		
4	HATCHING	3		
5	LABELS	2 1/2		
<b>SUBTOTAL</b>		<b>38</b>		
NORTH ELEVATION				
1	ROOF + RWDP + GULLEY	10 1/2		
2	WALLS + STEP + FFL	4		
3	DOOR + WINDOW	6		
4	LABELS	1		
<b>SUBTOTAL</b>		<b>21 1/2</b>		
DETAILED SECTION				
1	ROOF DETAIL	13 1/2		
2	SLAB, WALL, WINDOW + BASIN	12		
3	HATCHING	5 1/2		
4	LABELS	1 1/2		
<b>SUBTOTAL</b>		<b>32 1/2</b>		
<b>TOTAL</b>		<b>92</b>		
PENALTIES (-)				
<b>GRAND TOTAL</b>				
EXAMINATION NUMBER				
EXAMINATION NUMBER				6